



**GIS** Print 17/09/2021

# Appendix A

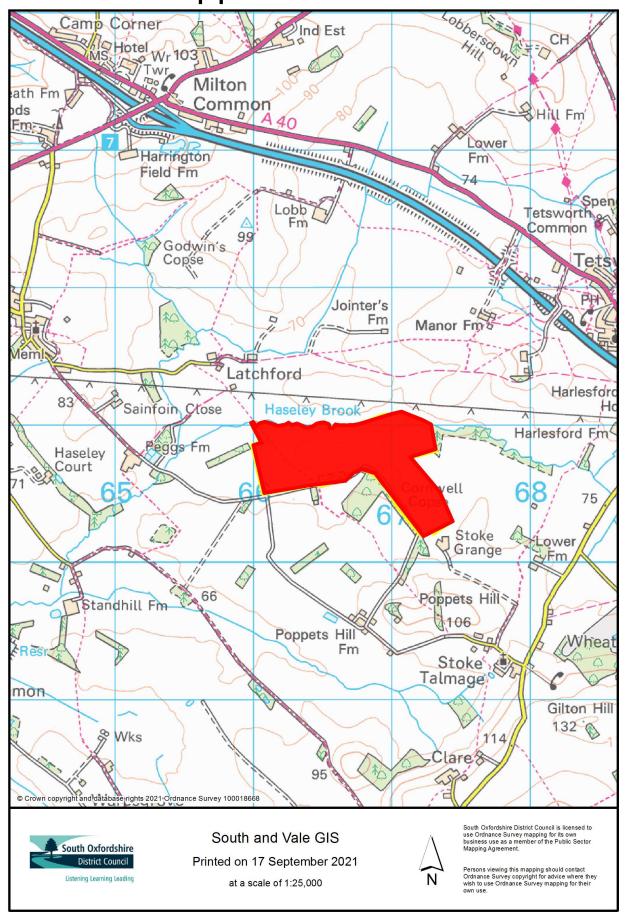

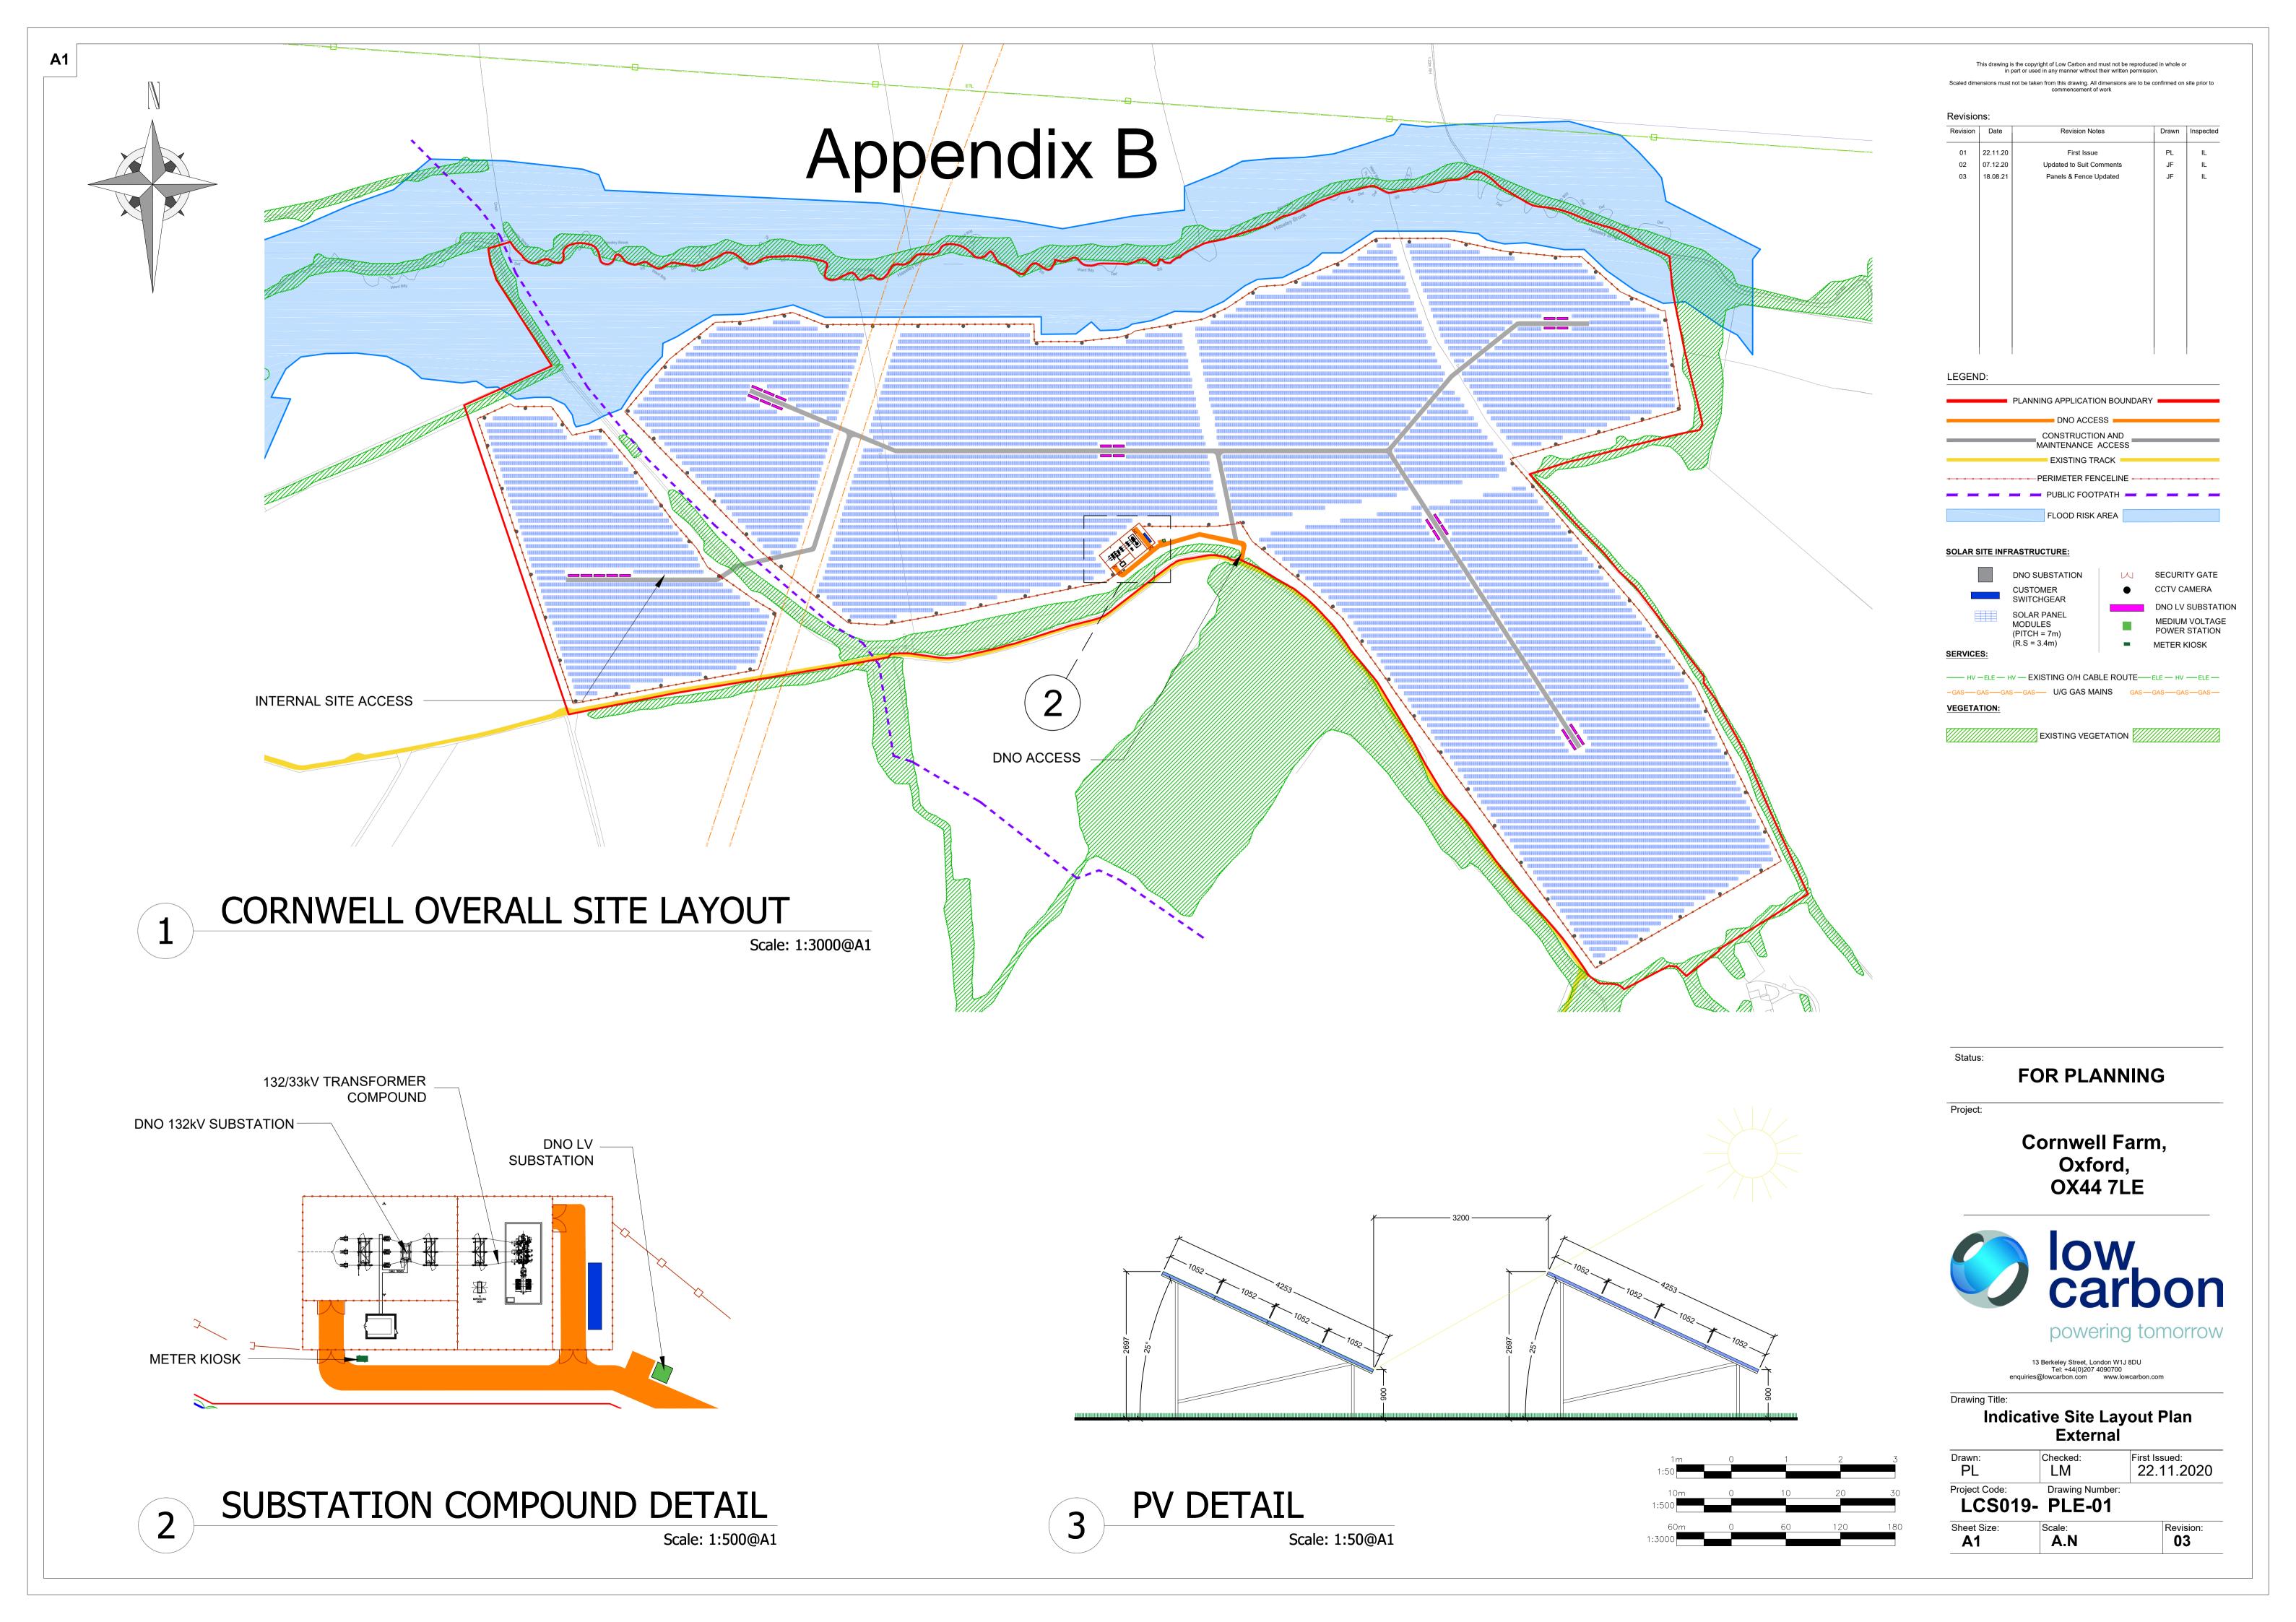

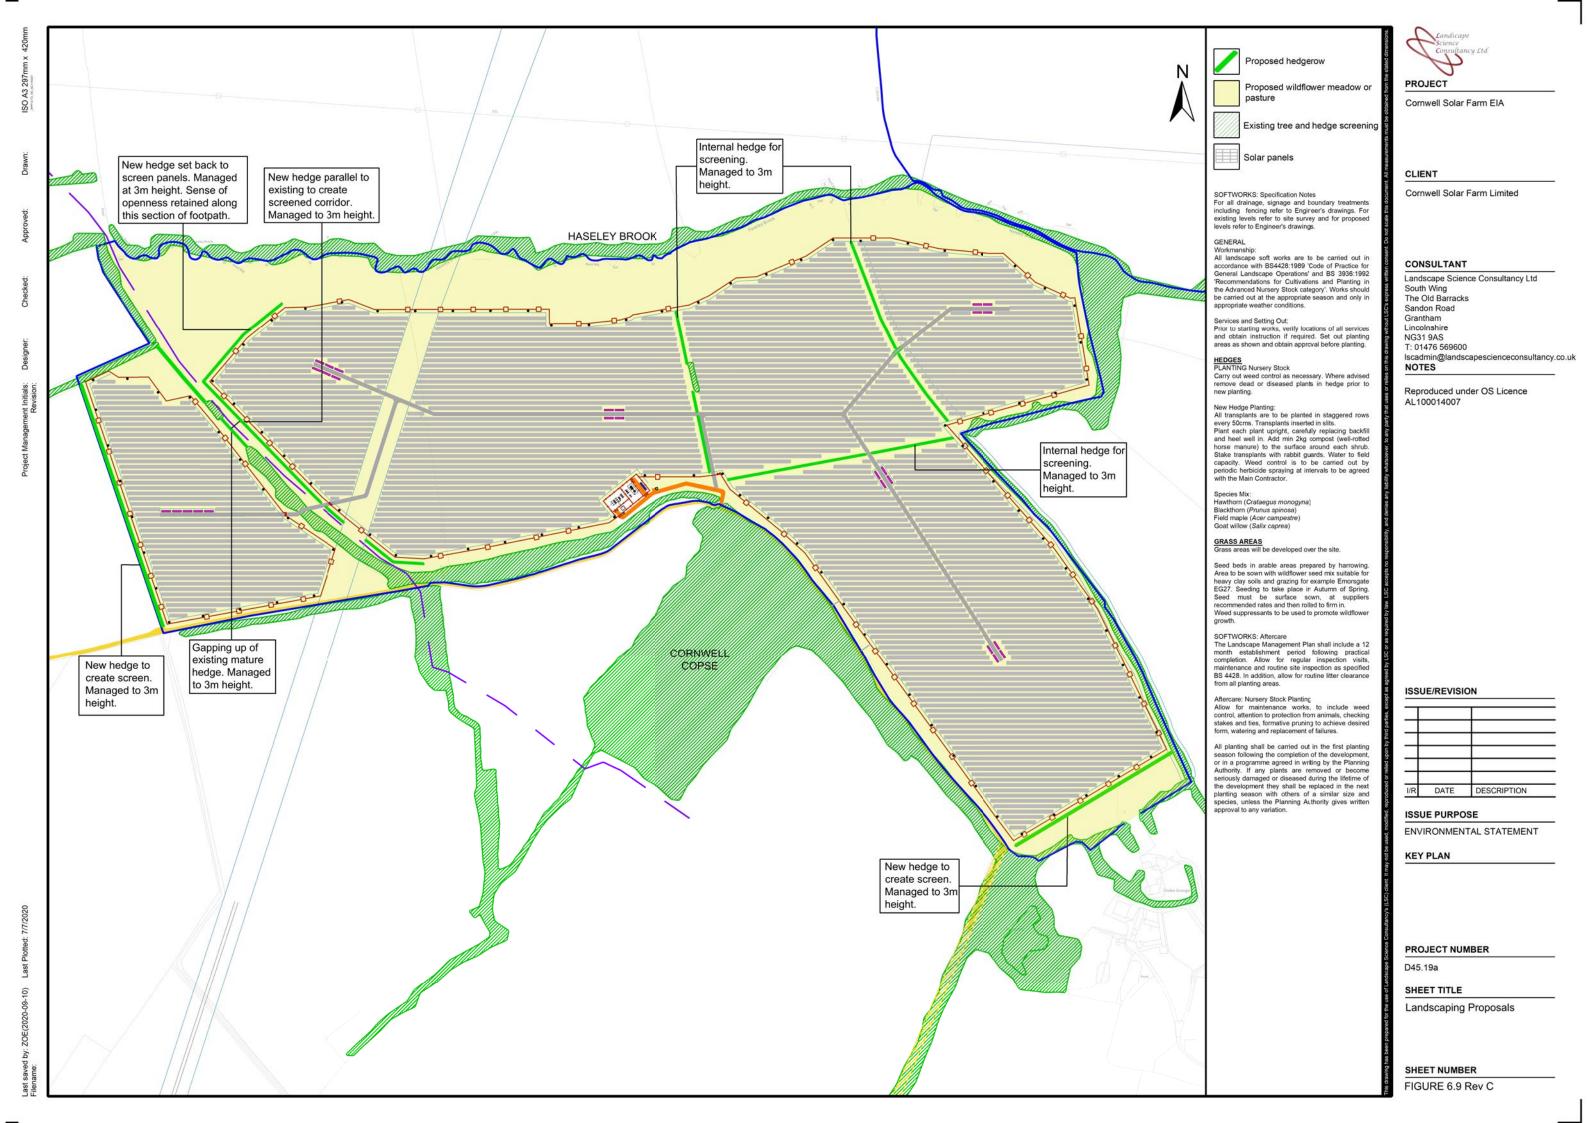

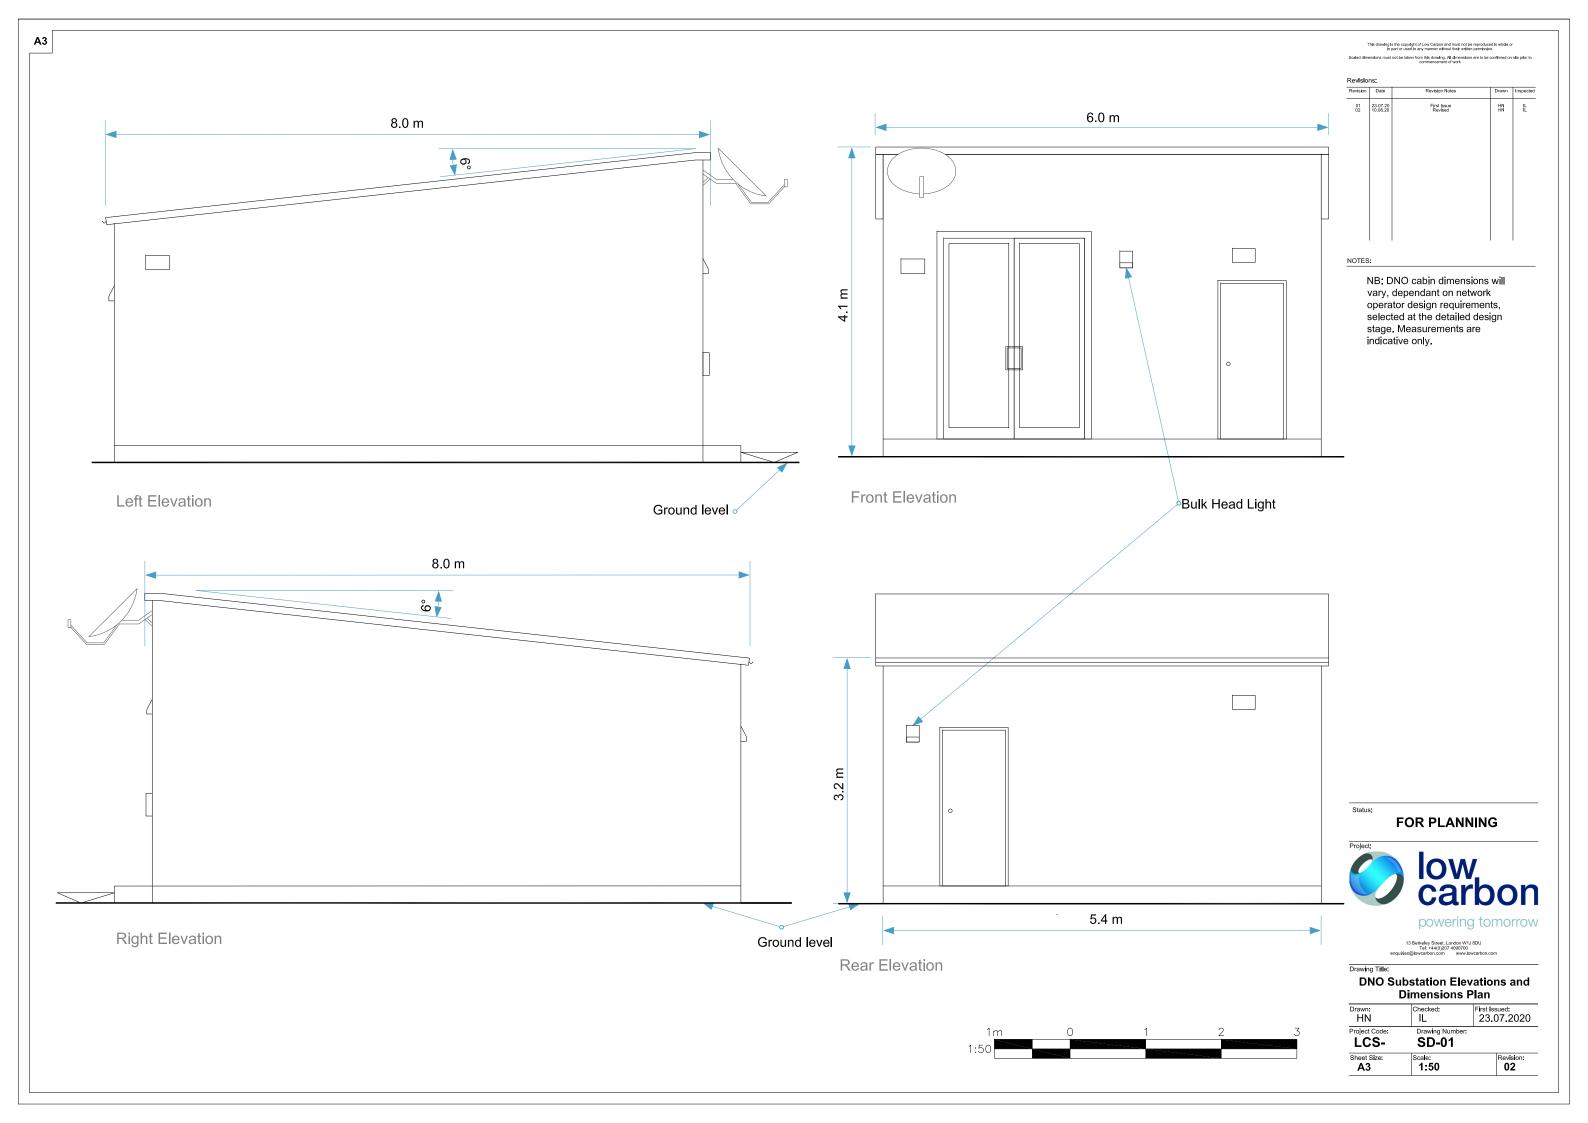




Front Elevation

Scaled dimensions must not be taken from this drawing. All dimensions are to be confirmed on site prior to commencement of work

Revision	Date	Revision Notes	Drawn	Inspected
01 02	23.07.20 10.08.20	First Issue Revised	HN	IL IL

NOTES:

NB: Customer Substation dimensions will vary, dependant on manufacturers selected at the detailed design stage. Measurements are indicative only.

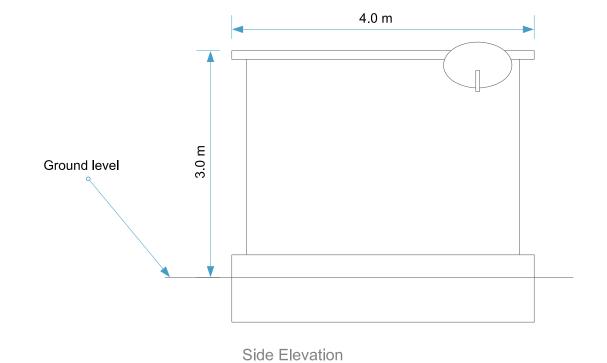


## FOR PLANNING



powering tomorrow

## Customer Substation Elevations and Dimensions Plan

	Dinichalona i lan		
Drawn: HN	Checked:	First Issued: 23.07.2020	
Project Code:	Drawing Number: SD-02		
Sheet Size:	Scale: 1:50	Revision: 02	

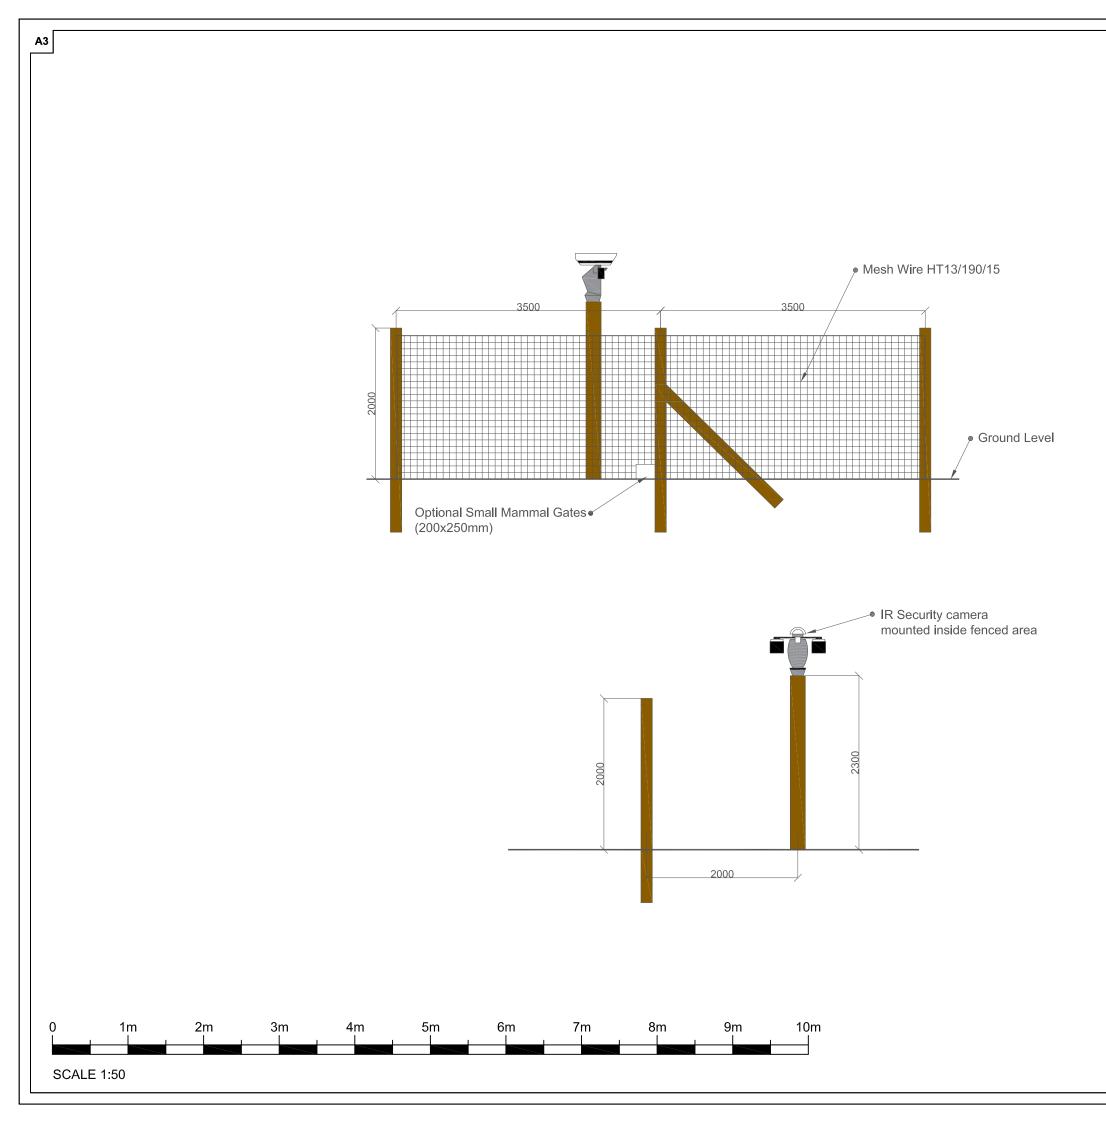

This drawing is the copyright of Low Carbon and must not be reproduced in whole or in part or used in any manner without their written permission. Scaled dimensions must not be taken from this drawing. All dimensions are to be confirm commencement of work

Revision	Date	Revision Notes	Drawn	Inspected
01 05 02 10	05.06.20 10.08.20	First Issue Revised	PL HN	IL IL

-The colour of the cabins and components on site will be painted RAL 6005 Moss Green, or to the LPA preference.

-Cameras to either be placed inside fenceline or mounted on directly onto fence posts. To be confirmed in the final EPC contract.


### **FOR PLANNING**



powering tomorrow


# Drawing Title: Security Fence and CCTV Standard Detail

Drawn: PL	Checked:	First Issued: 05.06.20
Project Code:	Drawing Number: SD-04	
Sheet Size:	Scale: 1-50	Revision:

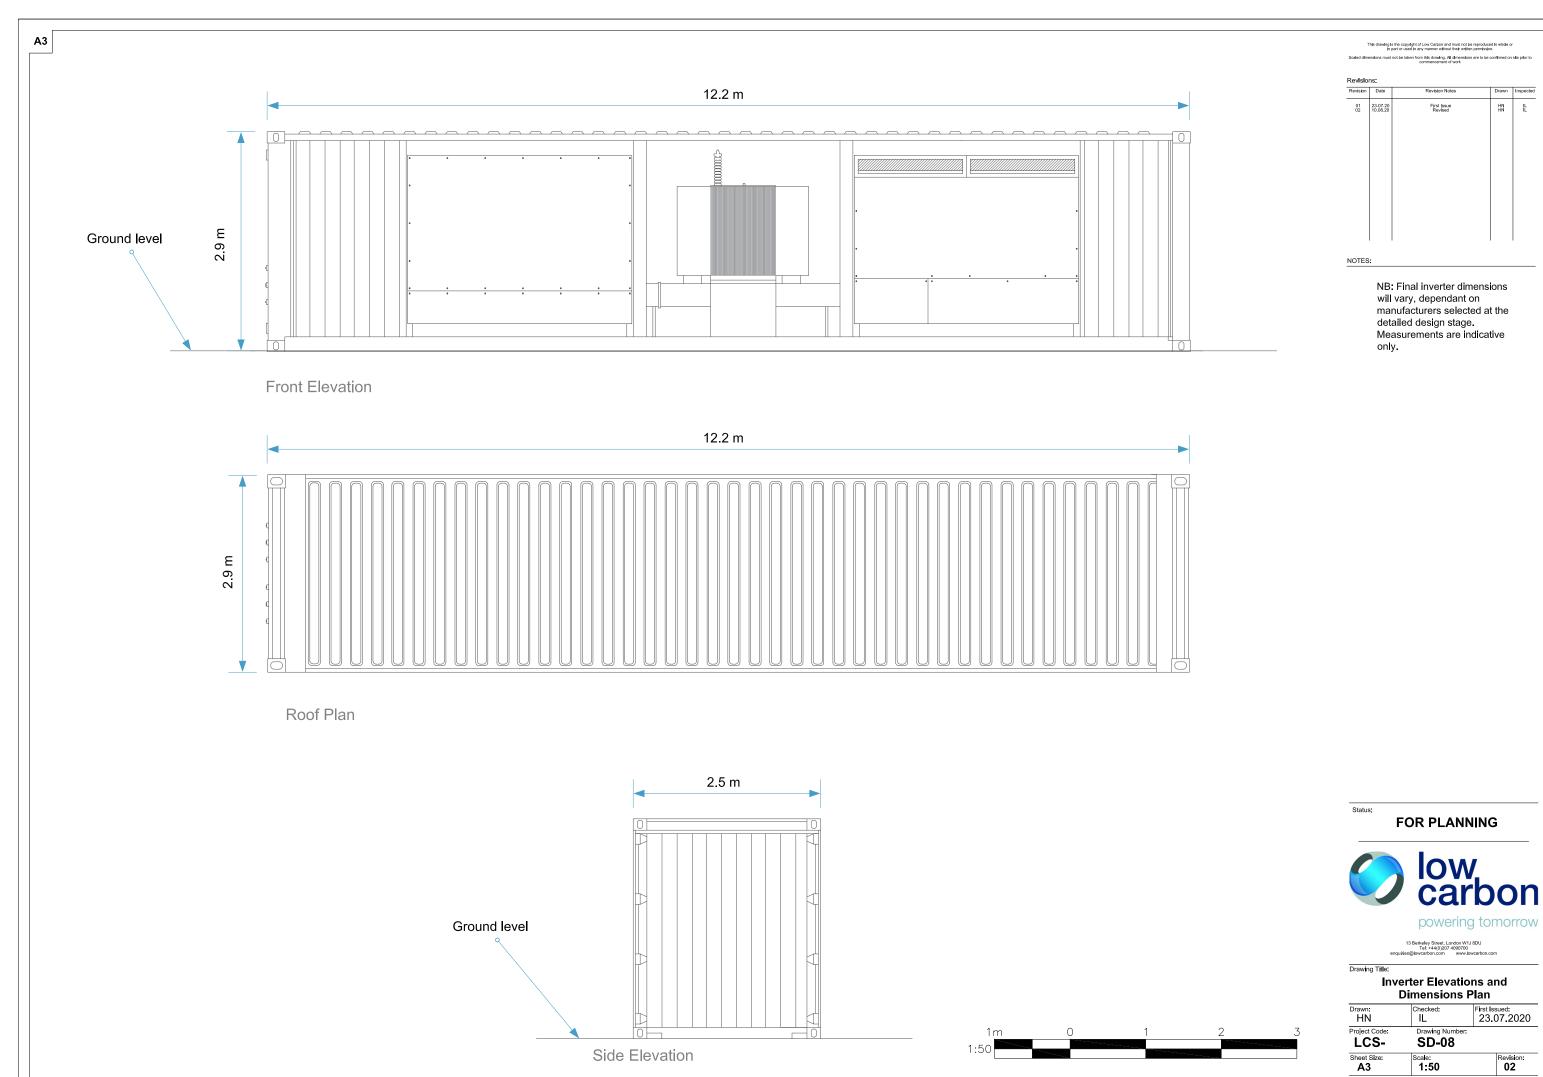

Revision	Date	Revision Notes	Drawn	Inspected
01 02	23.07.20 10.08.20	First Issue Revised	HN	IL IL

LEGEND:

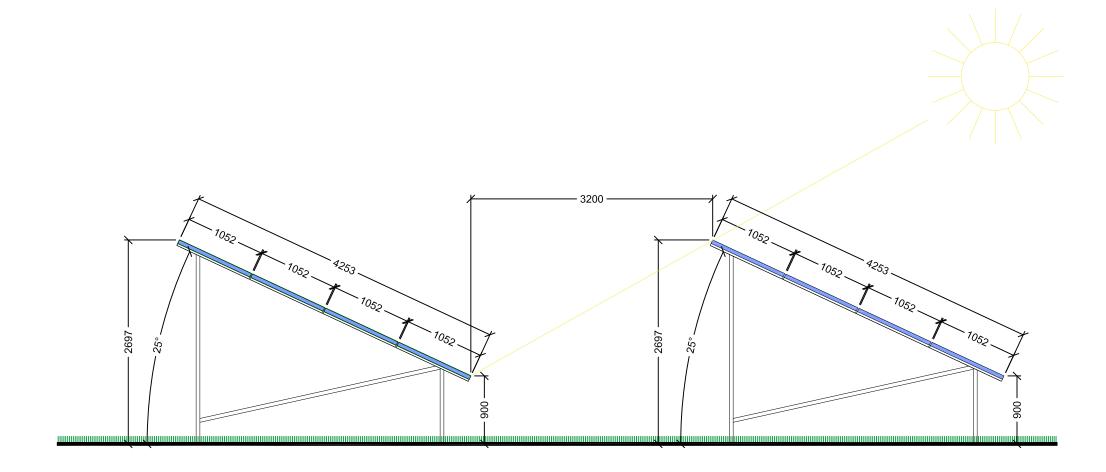

## FOR PLANNING



powering tomorrow


# Panel Arrangement 4 Landscape 25° Tilt

Drawn: HN	Checked: LF	First Issued: 23.07.2020
Project Code: LCS-	Drawing Number: SD-10	
Sheet Size:	Scale: 1:50	Revision: <b>02</b>

PANEL CROSS SECTION

Scale: 1:50@A3



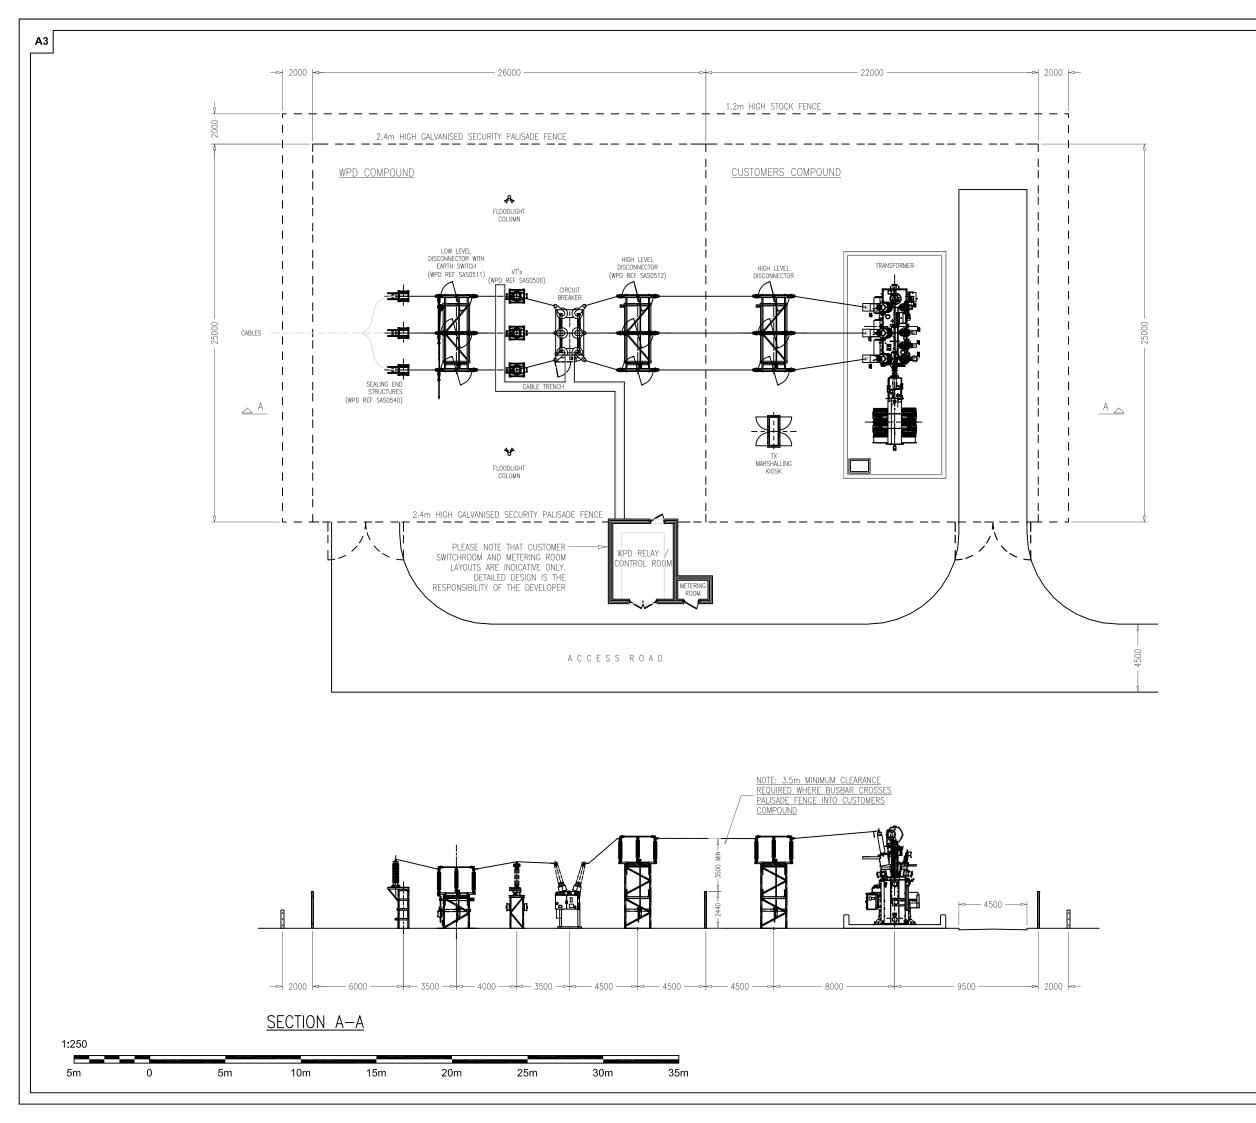

This drawing is the copyright of Low Carbon and must not be reproduced in whole or in part or used in any manner without their written permission. Scaled dimensions must not be taken from this drawing. All dimensions are to be confirm commencement of work

Revision	Date	Revision Notes	Drawn	Inspected
01	10.08.20	First Issue	HN	IL

NOTES:

**FOR PLANNING** 



powering tomorrow

Drawing Title:

### **Substation Compound Plan**

Drawn: HN	Checked:	First Issued: 10.08.2020
Project Code: LCS-	Drawing Number: SD-13	•
Sheet Size: A3	Scale: 1:250	Revision: 01

